


THIS PACKAGE HAS BEEN CREATED AS A MEANS TO SHOW THE OVERALL BUILDING SIZE AND LAYOUT OF THE INDIVIDUAL PIECES.

THIS IS NOT A "FOR CONSTRUCTION" PACKAGE PLEASE CONTACT NOVADOME FOR AN ENGINEERED PACKAGE.

classic series iso


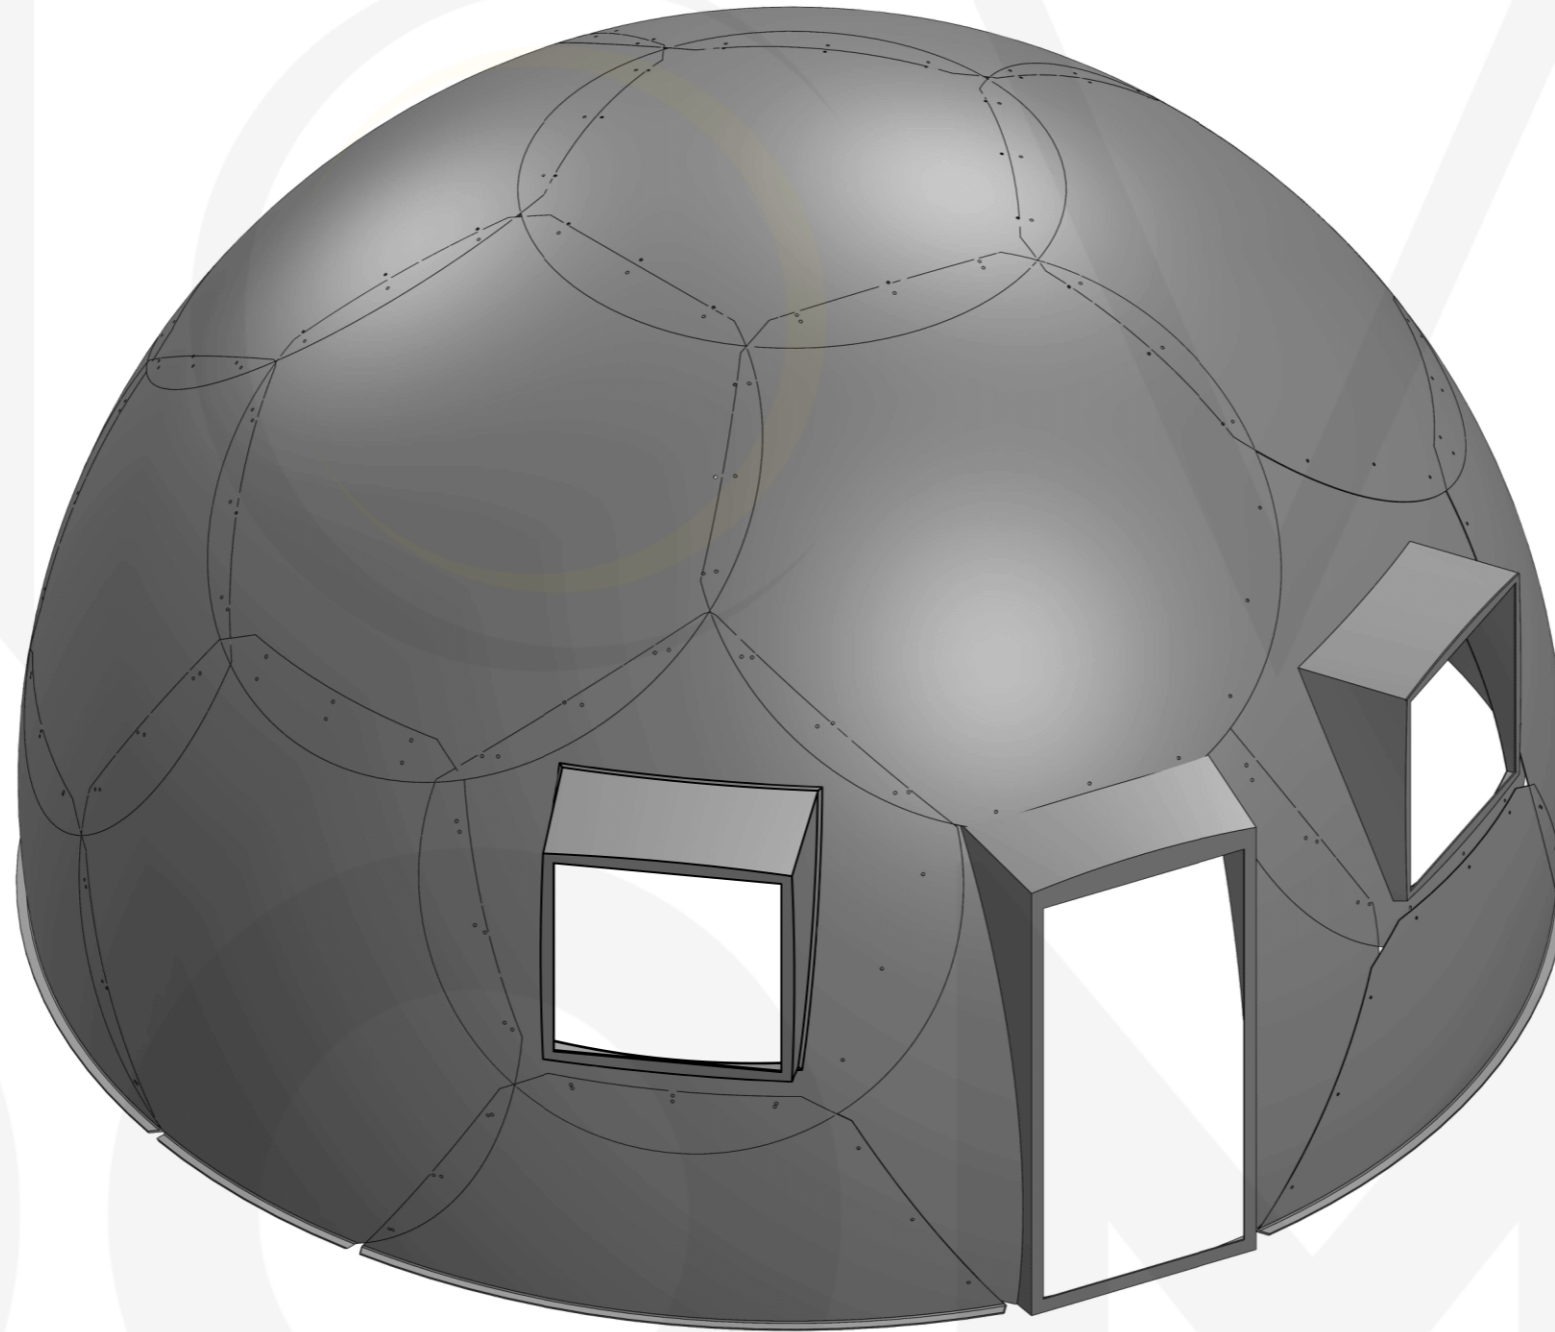


SHEETLIST	
PAGE 1	CLASSIC SERIES ISO
PAGE 2	CLASSIC SERIES DOMES DIMENSIONS
PAGE 3	BILL OF MATERIALS
PAGE 4	CONSTRUCTION ASSEMBLIES
PAGE 5	GENERAL NOTES

A	DRAFTING RELEASE. NOT FOR CONSTRUCTION	BS	
REV.	DESCRIPTION	DRAWN BY	APPROVED

UNLESS OTHERWISE SPECIFIED FRACTIONS = ± 1/16 .X = ± 0.030 .XX = ± 0.015 .XXX = ± 0.005 ANGLES = ± 1/2° REMOVE ALL BURRS AND SHARP CORNERS		
		SHEET 1 OF 5

# classic series dome dimensions

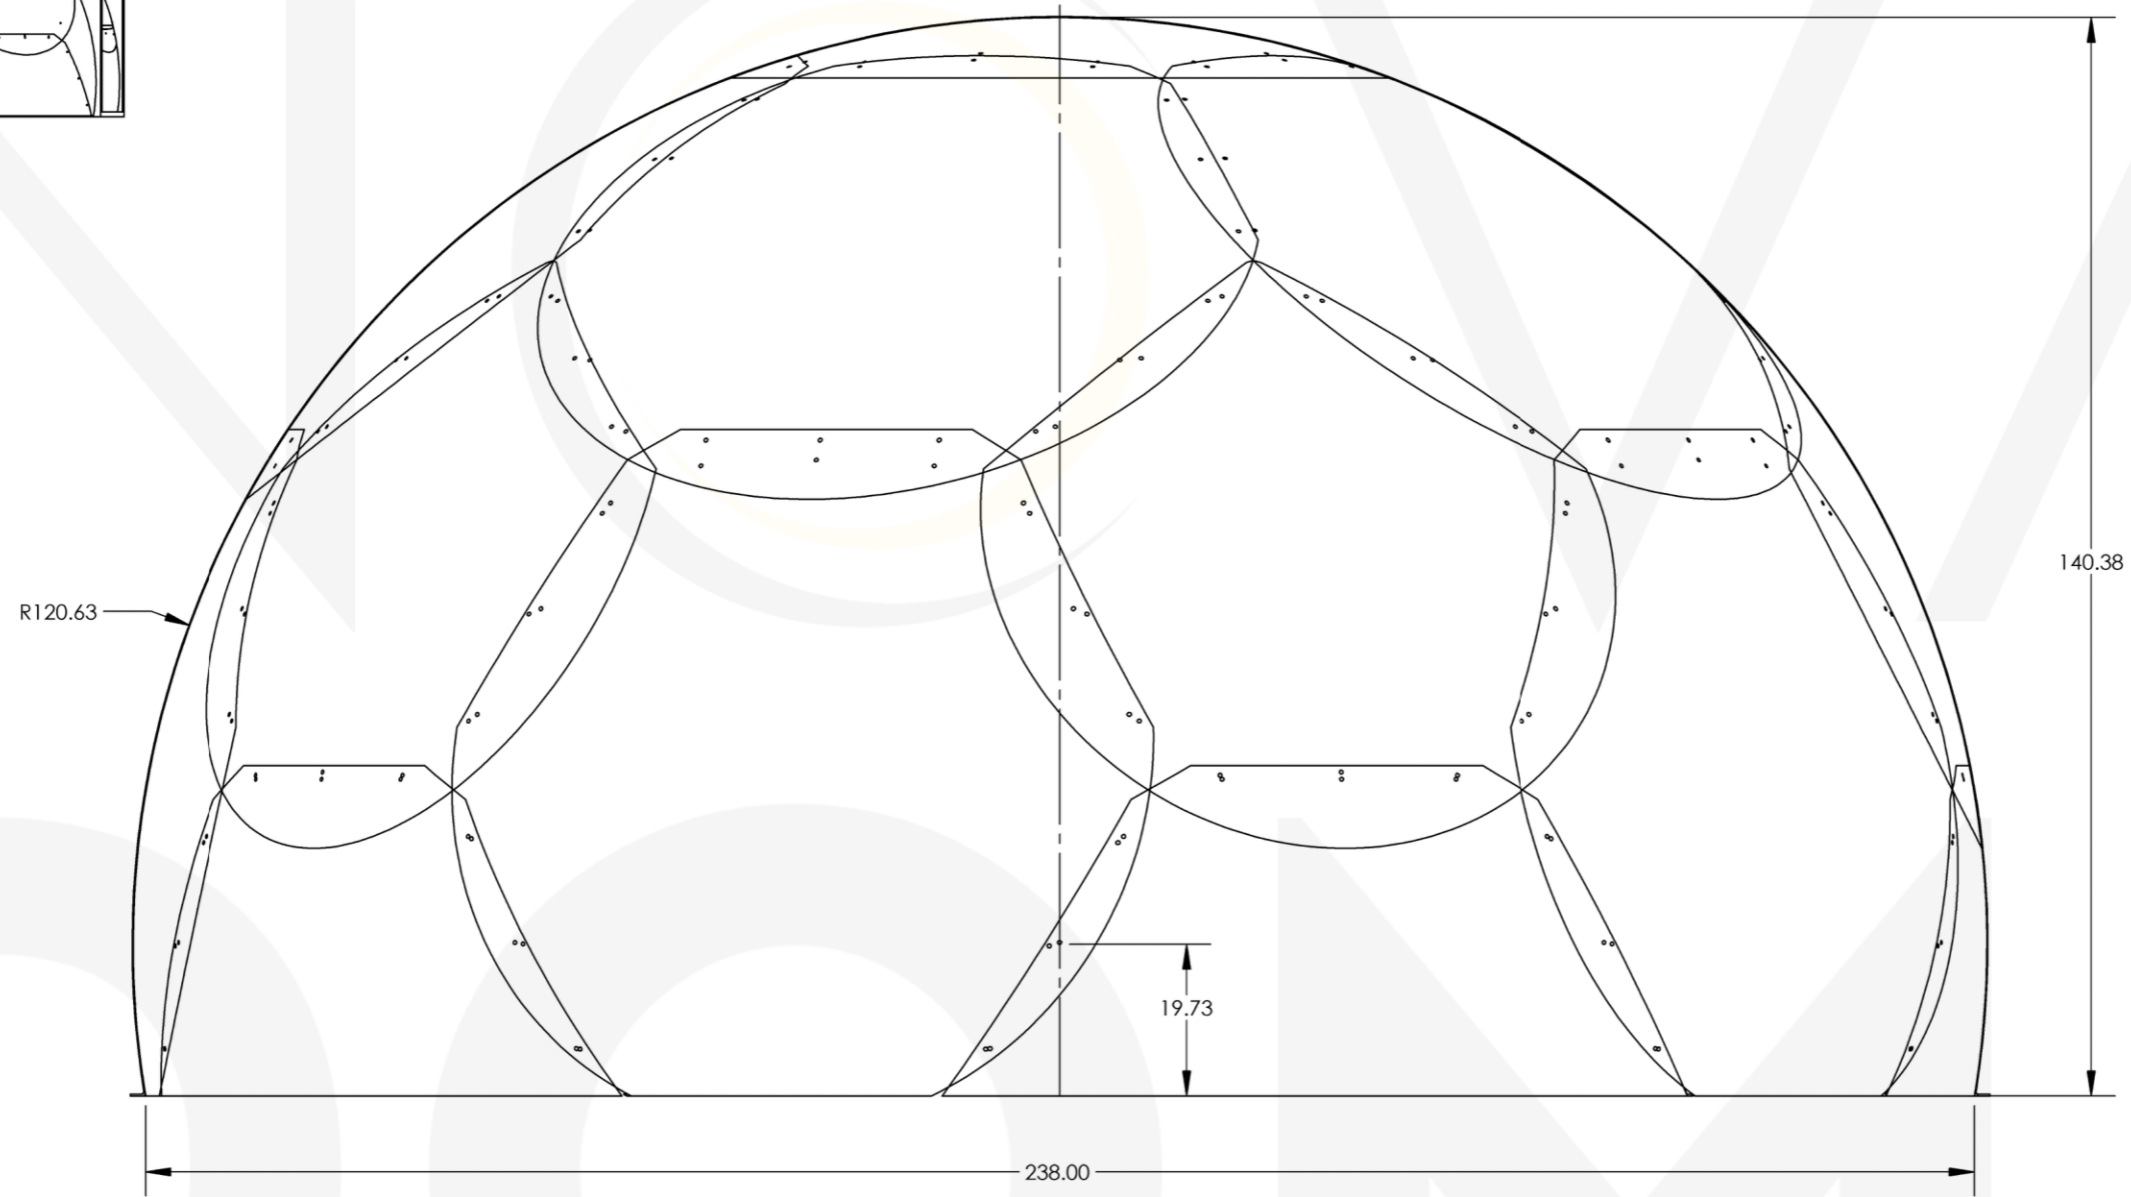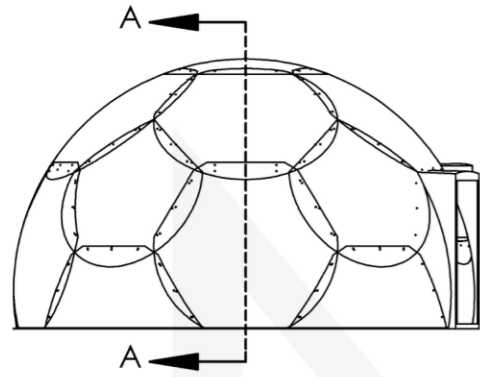


SECTION A-A  
SCALE 1 : 25

UNLESS OTHERWISE SPECIFIED  
 FRACTIONS = ± 1/16  
 .X = ± 0.030  
 .XX = ± 0.015  
 .XXX = ± 0.005  
 ANGLES = ± 1/2°  
 REMOVE ALL BURRS AND SHARP  
 CORNERS

**NOVA DOME**


SHEET  
2 OF 5

# classic series bill of materials

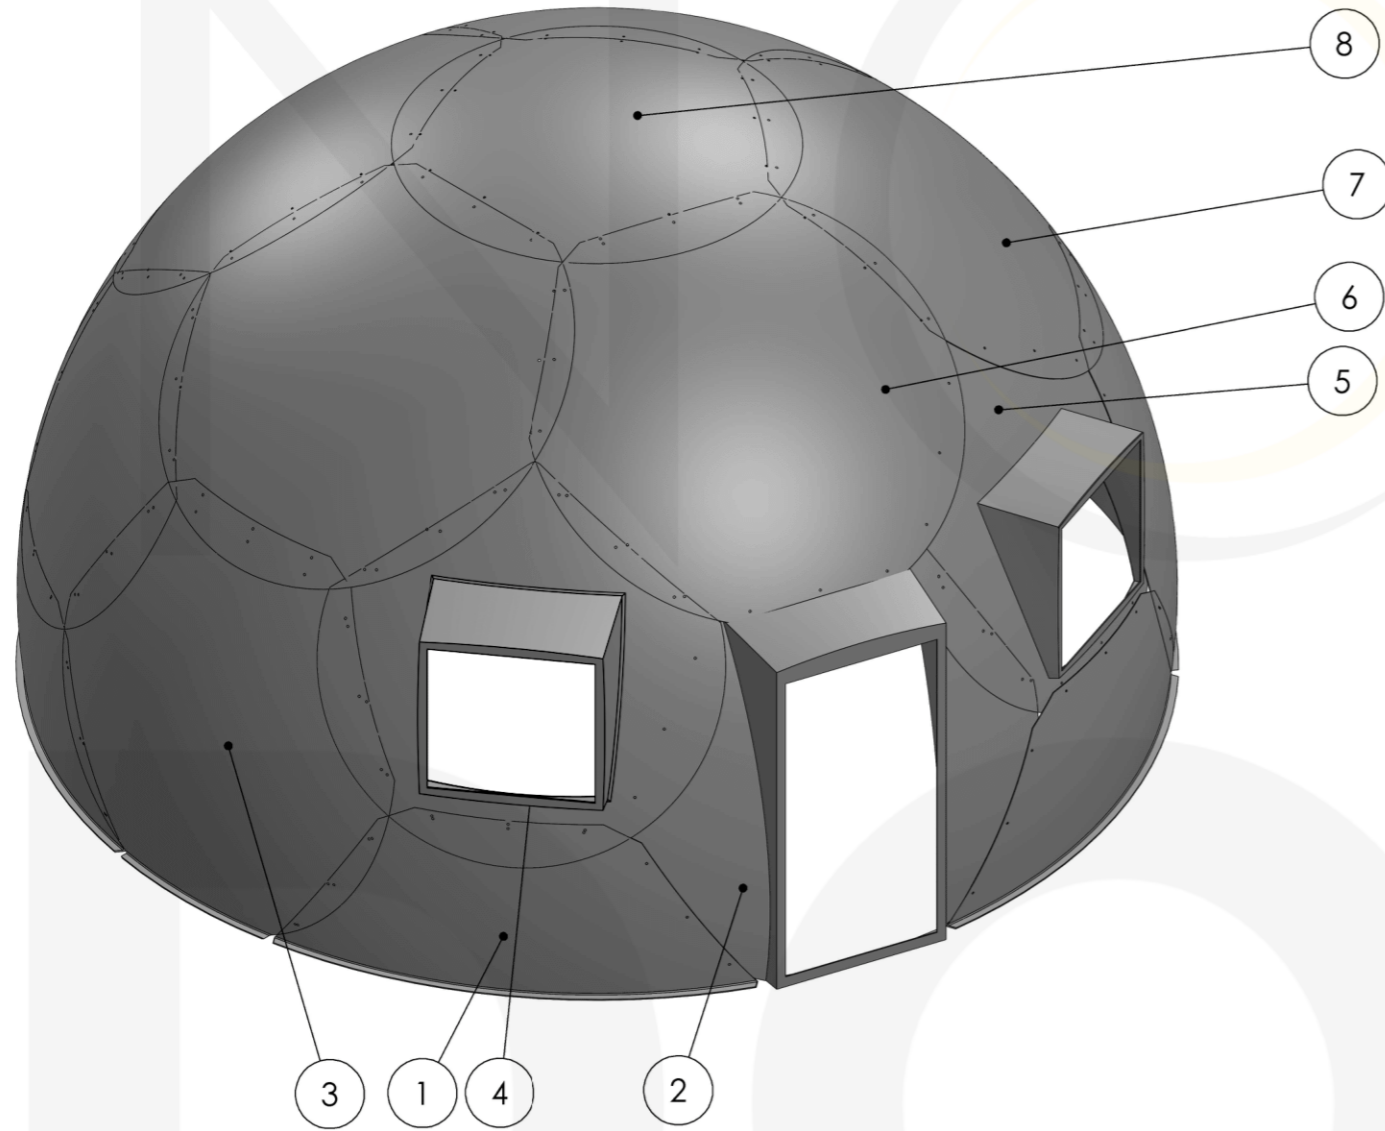


ITEM NO.	PART NUMBER	DESCRIPTION	QTY.
1	NOVA-001-20-A	PANEL A	5
2	NOVA-001-20-B	PANEL B	1
3	NOVA-001-20-C	PANEL C	4
4	NOVA-001-20-D	PANEL D	4
5	NOVA-001-20-E	PANEL E	1
6	NOVA-001-20-F	PANEL F	1
7	NOVA-001-20-G	PANEL G	4
8	NOVA-001-20-H	PANEL H	1

NOTE:  
 WINDOW PANEL E ARE INTERCHANGEABLE WITH PANEL D  
 DOOR PANEL B ARE INTERCHANGEABLE WITH PANEL C

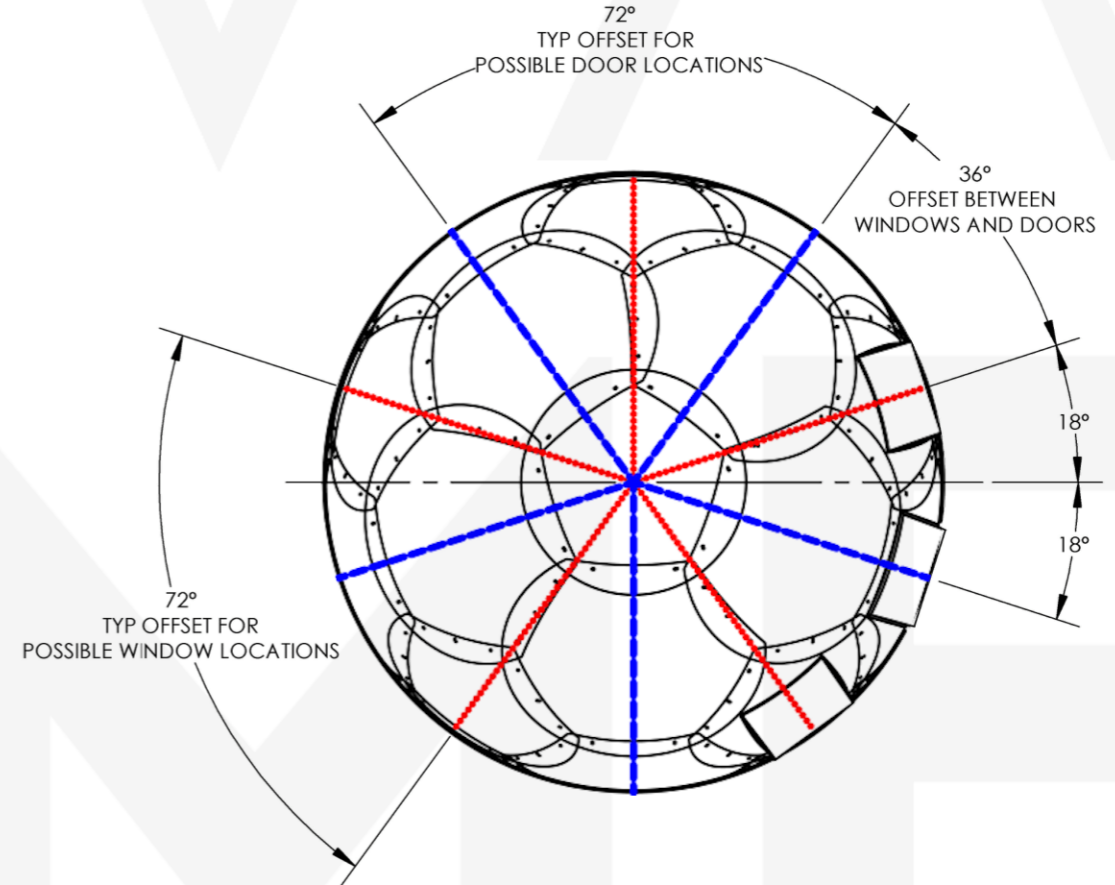

UNLESS OTHERWISE SPECIFIED  
 FRACTIONS = ± 1/16  
 .X = ± 0.030  
 .XX = ± 0.015  
 .XXX = ± 0.005  
 ANGLES = ± 1/2°  
 REMOVE ALL BURRS AND SHARP CORNERS

# NOVA DOME

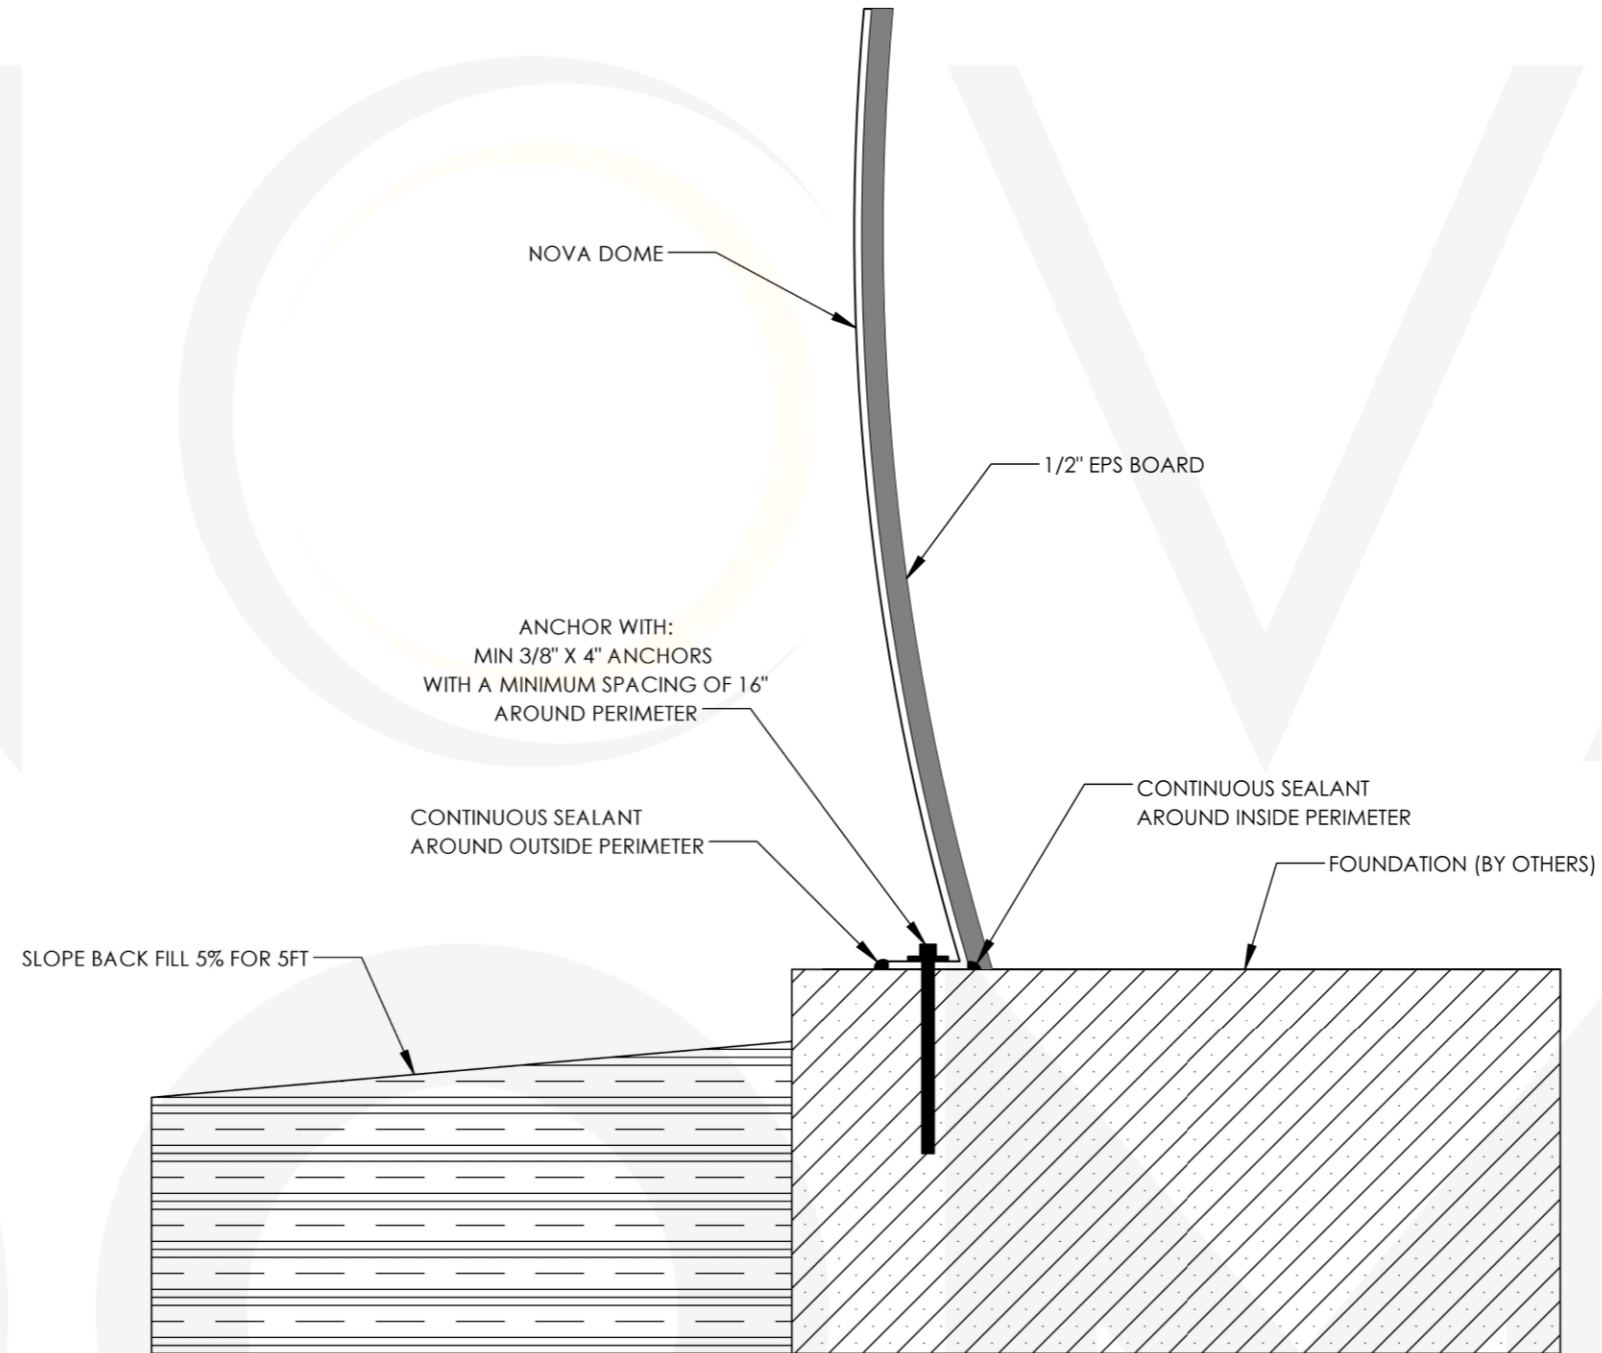


**WALL DESCRIPTION:**  
 - FIBREGLASS NOVADOME  
 - 1/2" EPS BOARD WITH A FABRIC FINISH

UNLESS OTHERWISE SPECIFIED  
 FRACTIONS = ± 1/16  
 .X = ± 0.030  
 .XX = ± 0.015  
 .XXX = ± 0.005  
 ANGLES = ± 1/2°  
 REMOVE ALL BURRS AND SHARP  
 CORNERS

**NOVA DOME**

# classic series floor planning layout

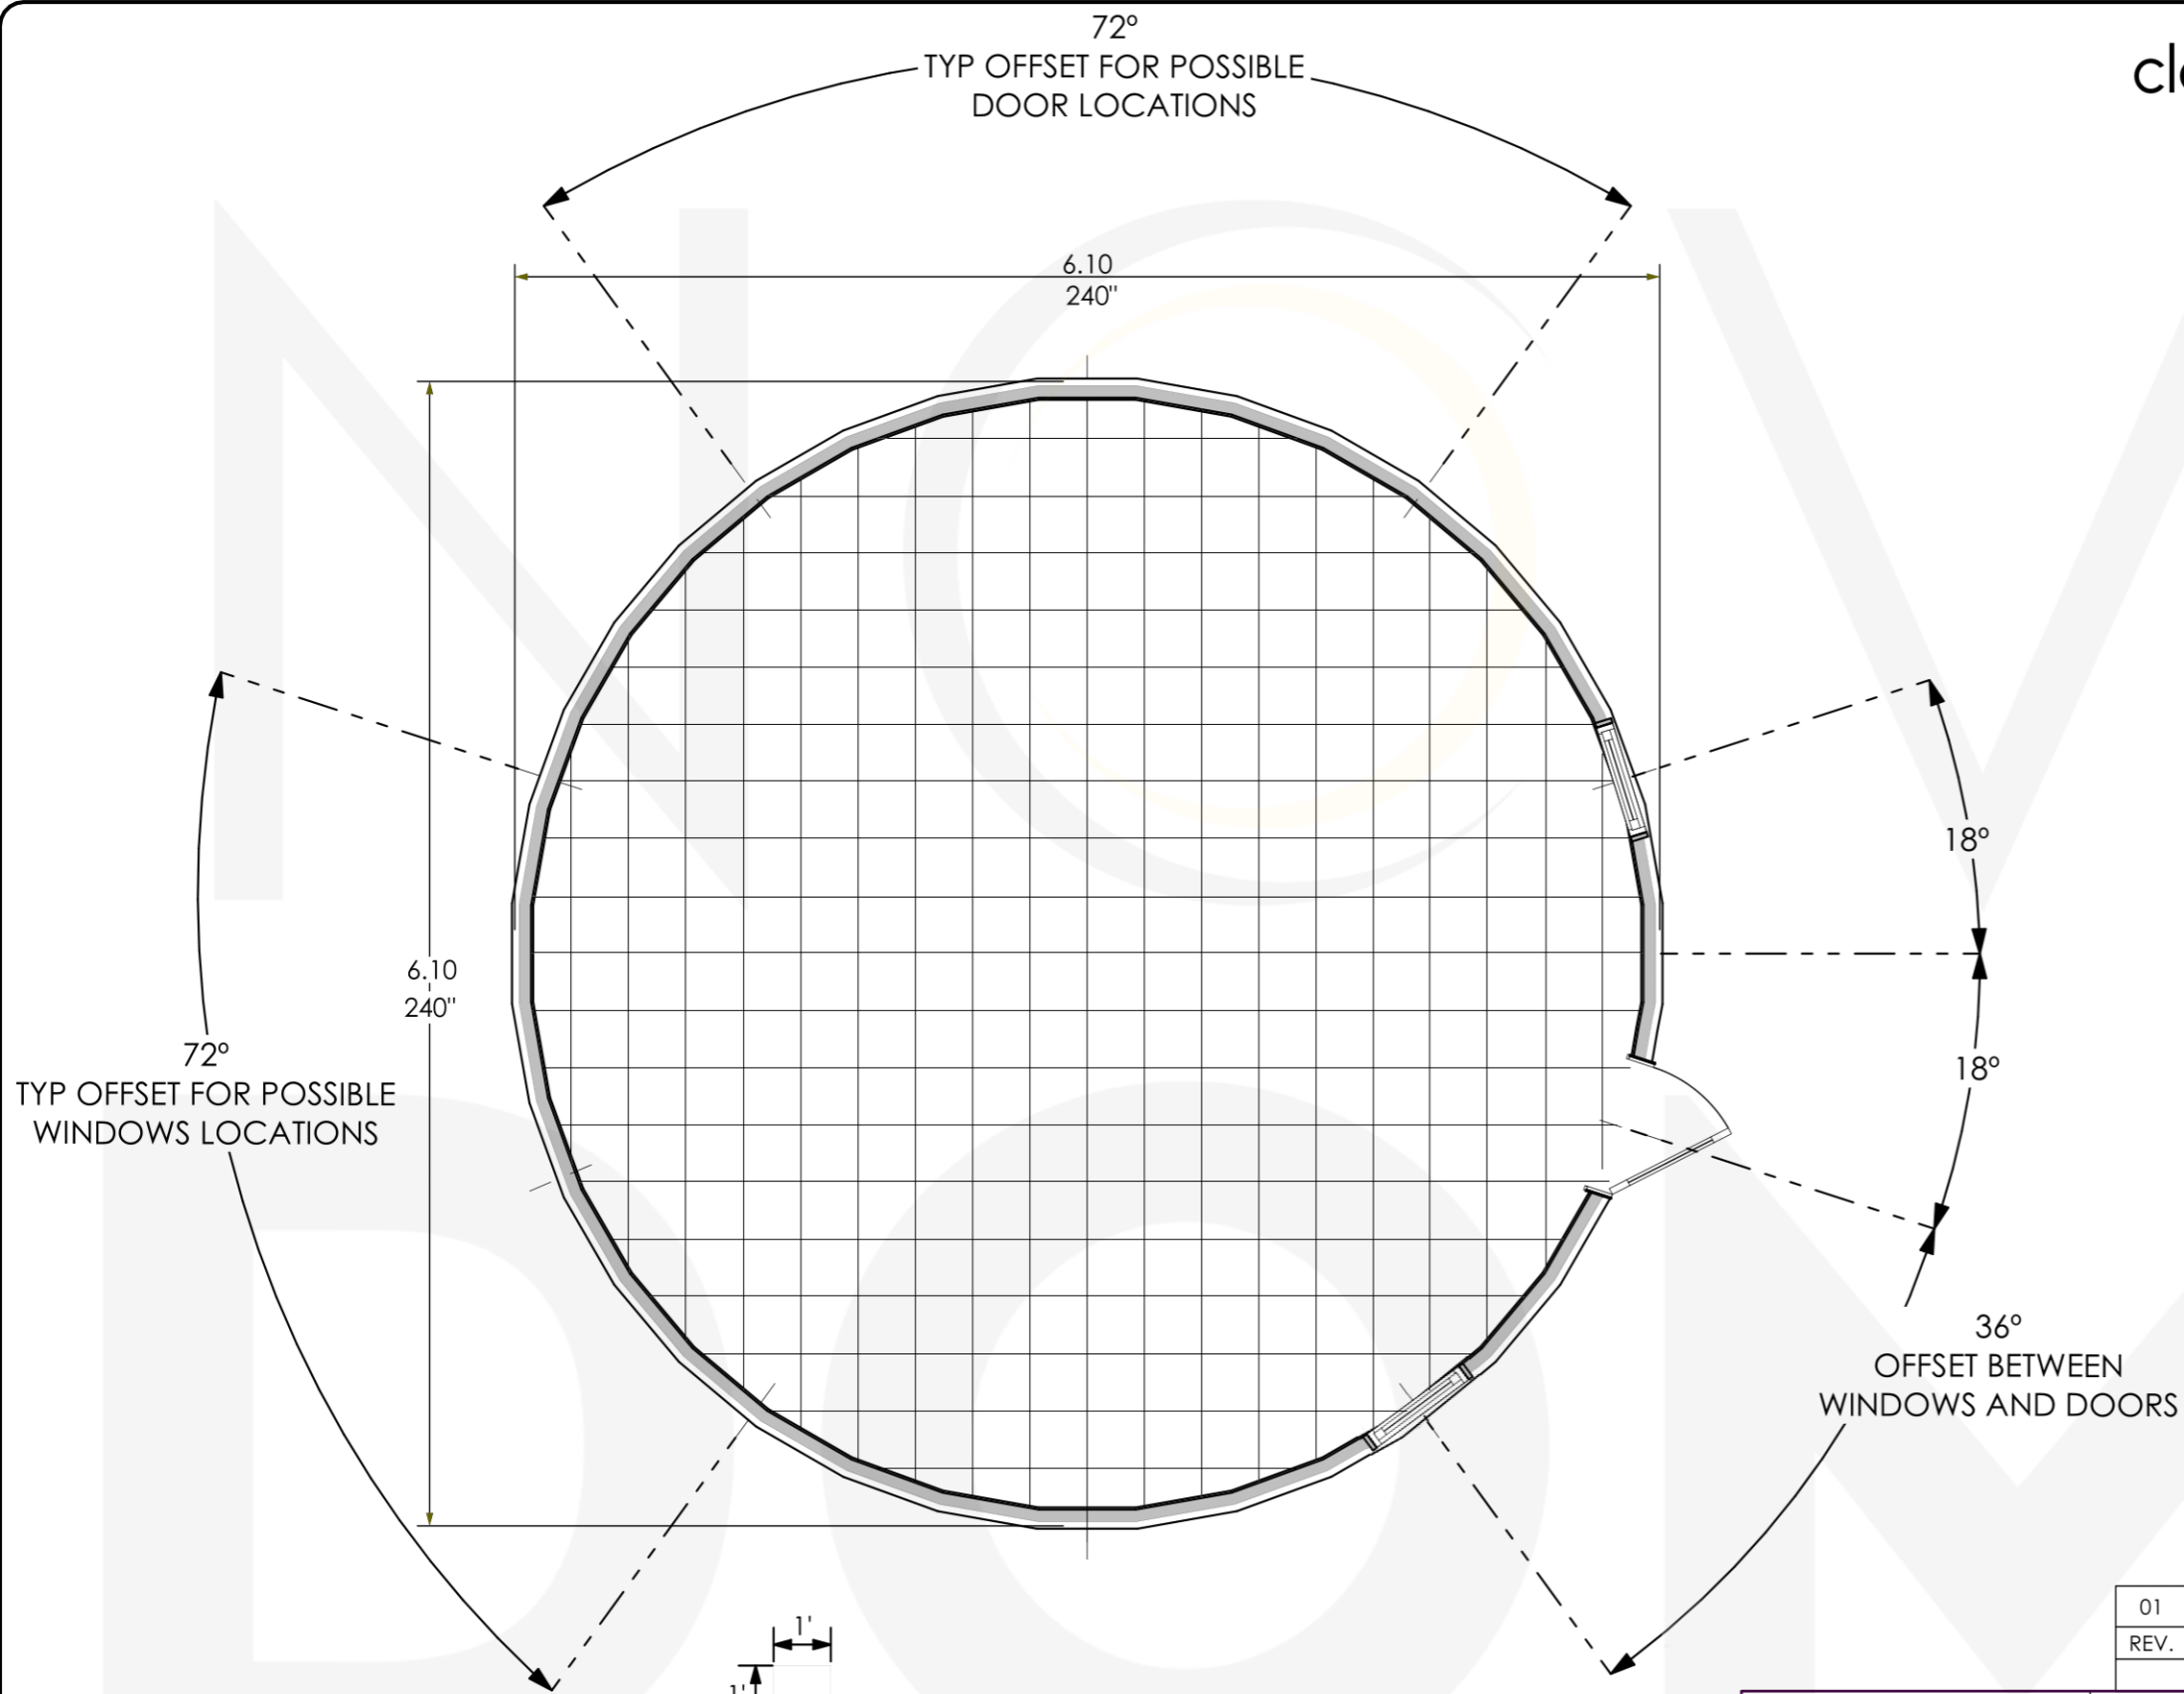

01	INITIAL DRAFTING RELEASE	BK	BS
REV.	DESCRIPTION	DRAWN BY	APPROVED

UNLESS OTHERWISE SPECIFIED  
 FRACTIONS = ± 1/16  
 .X = ± 0.030  
 .XX = ± 0.015  
 .XXX = ± 0.005  
 ANGLES = ± 1/2°  
 REMOVE ALL BURRS AND SHARP  
 CORNERS

**NOVA DOME**