

THIS PACKAGE HAS BEEN CREATED AS A MEANS TO SHOW THE OVERALL BUILDING SIZE AND LAYOUT OF THE INDIVIDUAL PIECES.

THIS IS NOT A "FOR CONSTRUCTION" PACKAGE PLEASE CONTACT NOVADOME FOR AN ENGINEERED PACKAGE.

astro series iso



SHEET INDEX

1	DOMES ISO VIEW
2	DOMES DIMENSIONS
3	BILL OF MATERIALS
4	CONSTRUCTION ASSEMBLIES
5	FLOOR PLAN
6	GENERAL NOTES



REV.	DESCRIPTION	LN	DRAWN BY	APPROVED
------	-------------	----	----------	----------

UNLESS OTHERWISE SPECIFIED
 FRACTIONS= ± 1/16
 .X = ± 0.030
 .XX = ± 0.015
 .XXX = ± 0.005
 ANGLES = ± 1/2°
 REMOVE ALL BURRS AND SHARP CORNERS

NOVA DOME

SHEET
1 OF 6



astro series dome dimensions

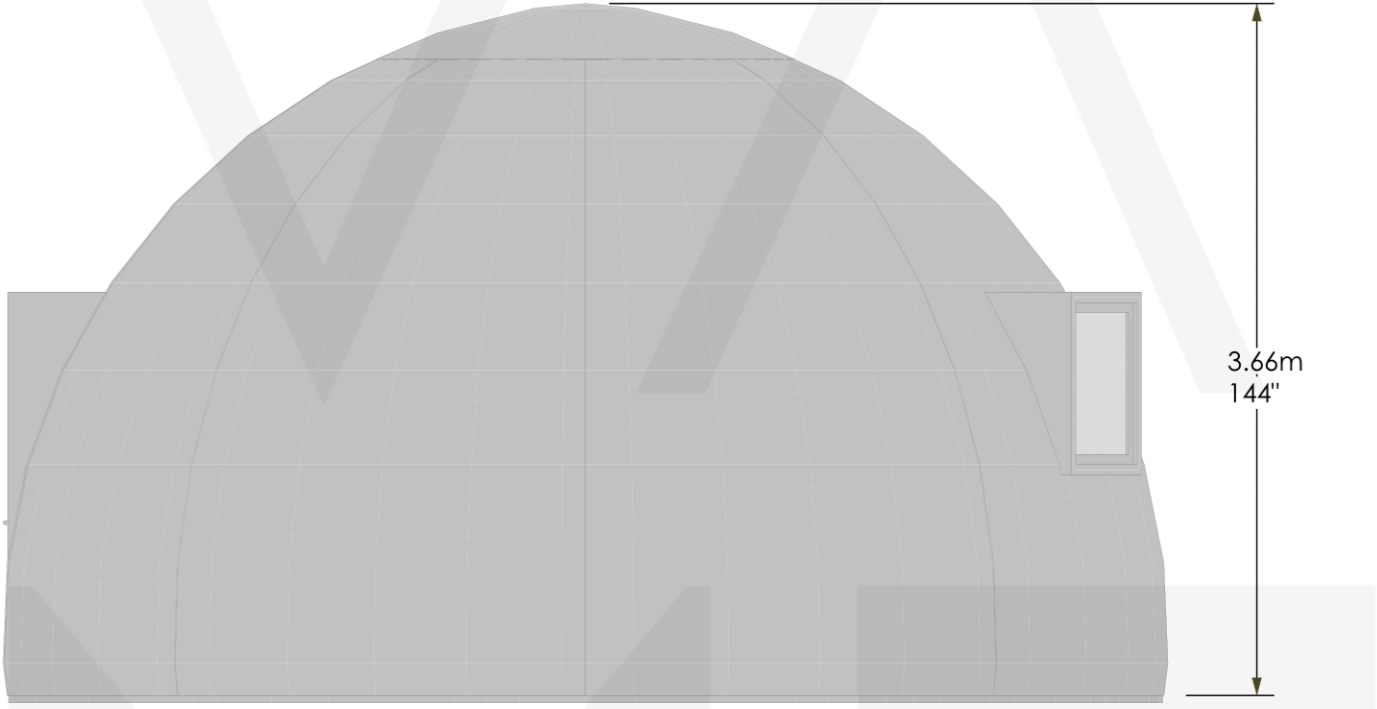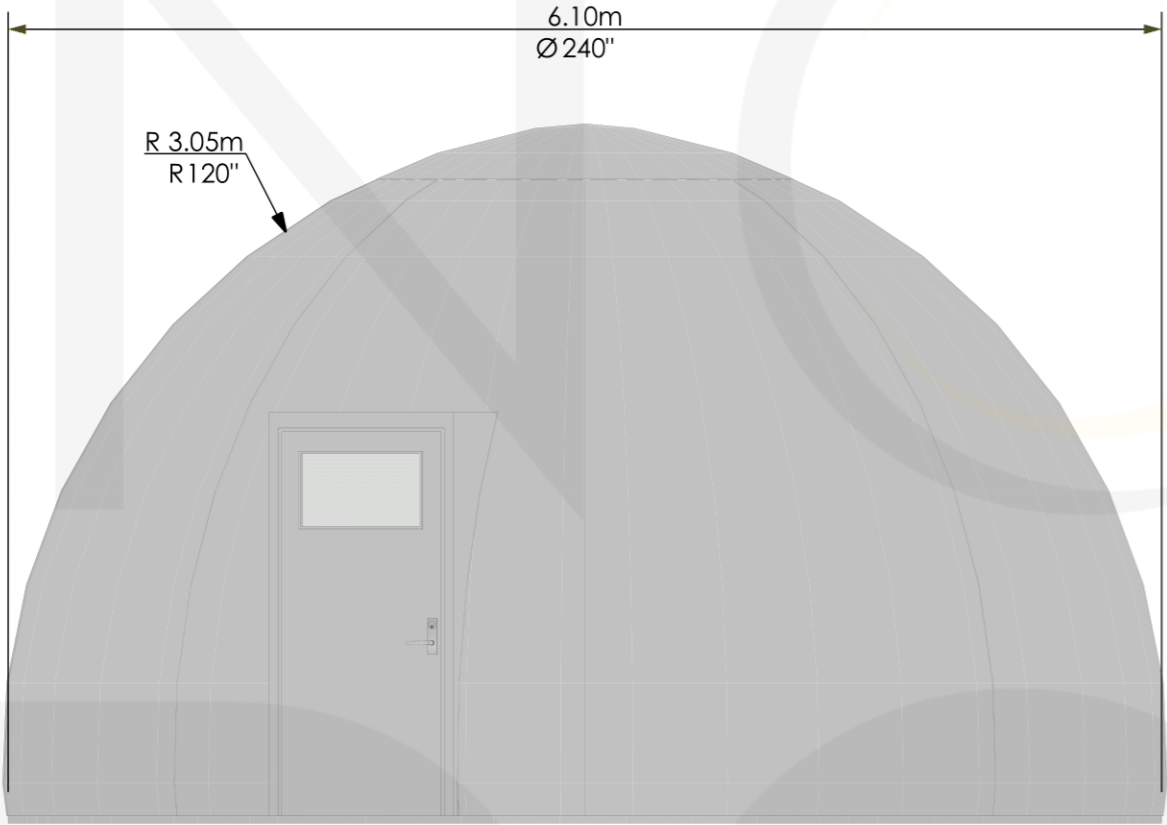

REV.	DESCRIPTION	LN	DRAWN BY	APPROVED
UNLESS OTHERWISE SPECIFIED FRACTIONS= ± 1/16 .X = ± 0.030 .XX = ± 0.015 .XXX = ± 0.005 ANGLES = ± 1/2° REMOVE ALL BURRS AND SHARP CORNERS				
				SHEET 2 OF 6

astro series bill of materials

ITEM NO.	QTY.	PART NUMBER	DESCRIPTION
1	6	NOVA-012-20MD-001	DOME PANEL
2	1	NOVA-012-20MD-002	DOME PANEL WITH DOOR
3	1	NOVA-012-20MD-003	DOME PANEL WITH WINDOW
4	1	NOVA-012-20MD-004	TOP CAP

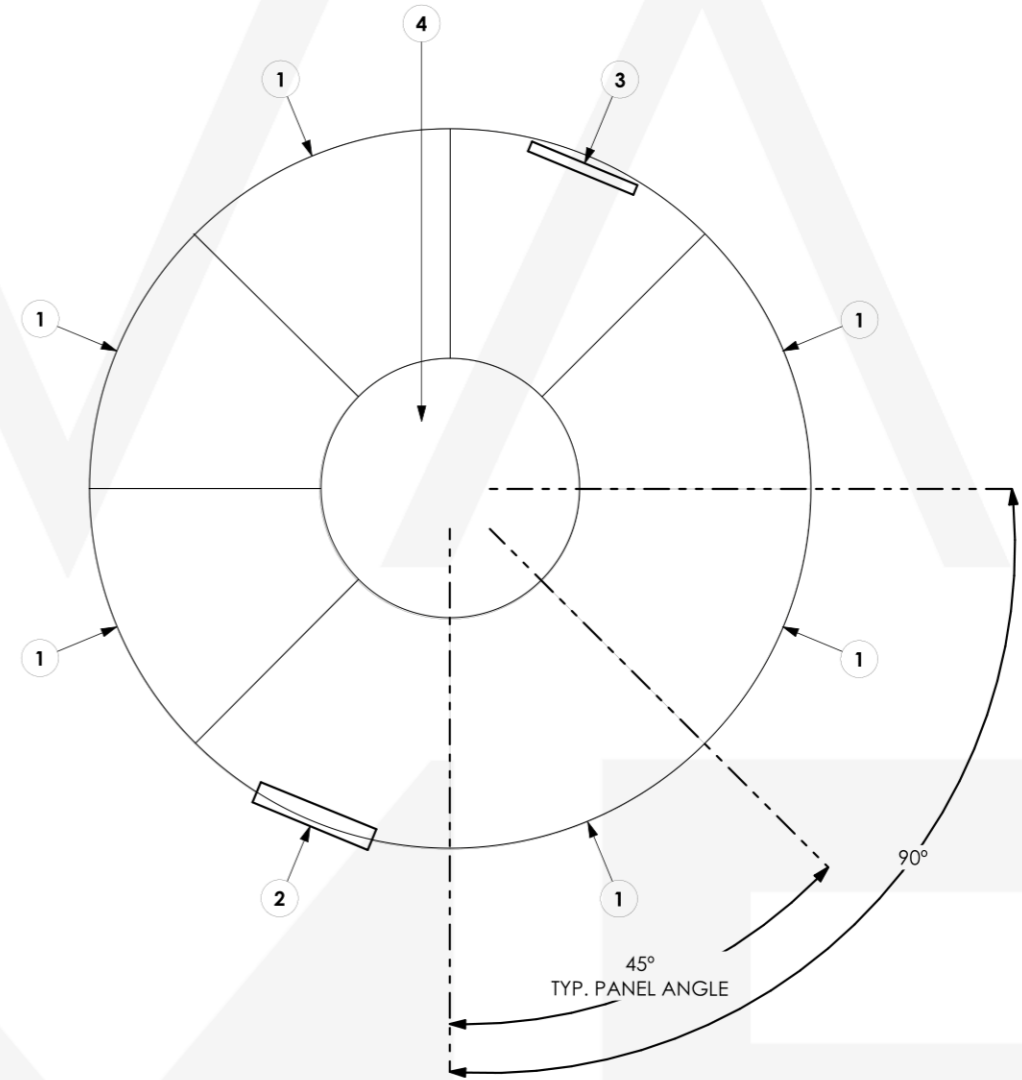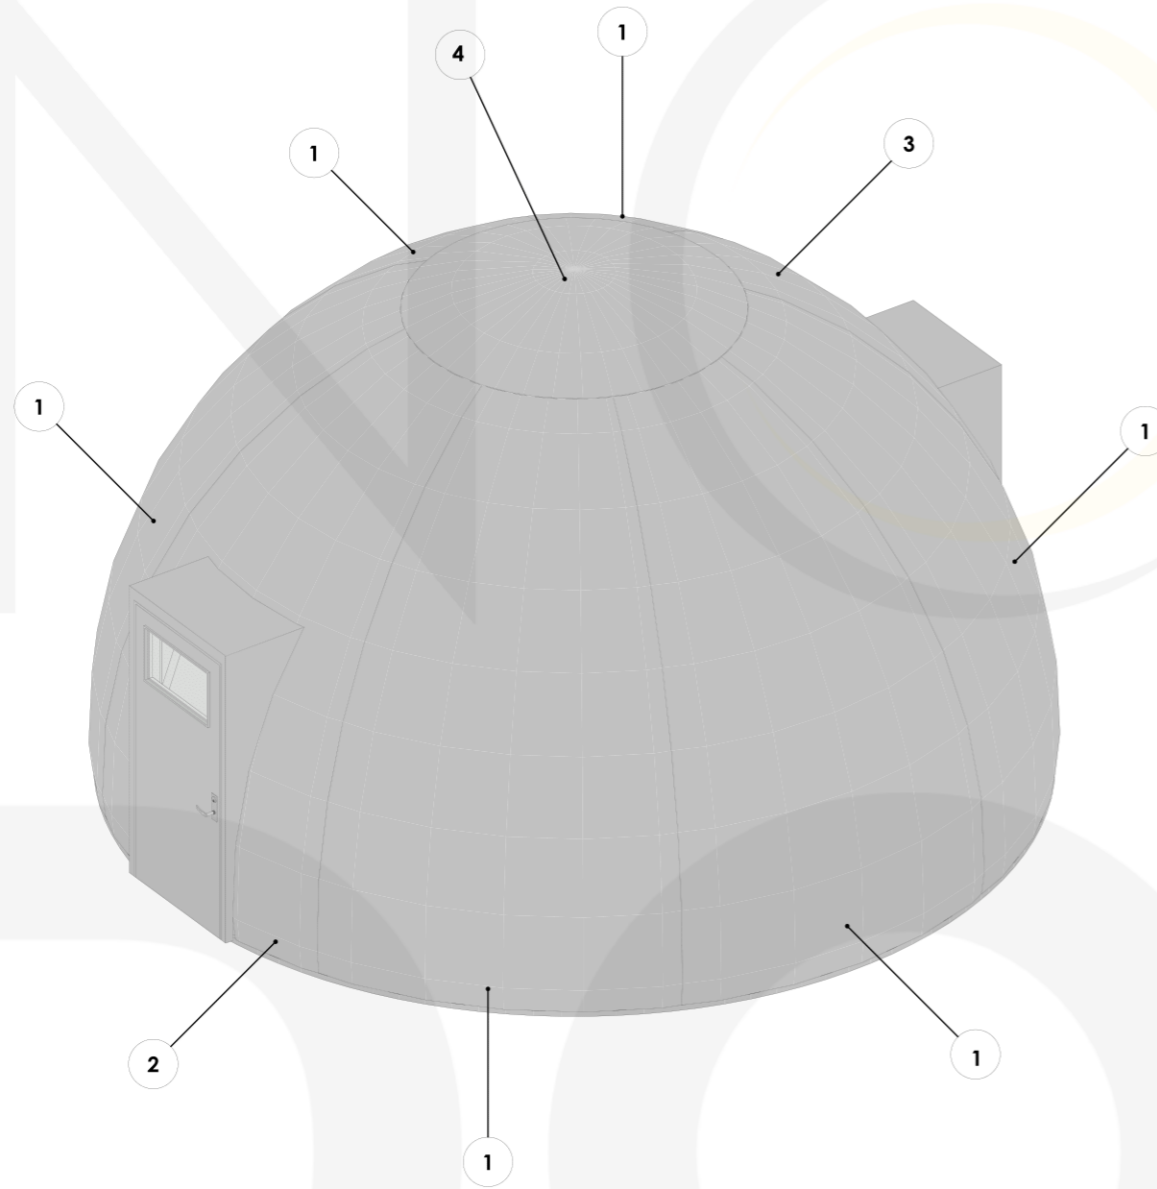


REV.	DESCRIPTION	LN	DRAWN BY	APPROVED

UNLESS OTHERWISE SPECIFIED
 FRACTIONS = ± 1/16
 .X = ± 0.030
 .XX = ± 0.015
 .XXX = ± 0.005
 ANGLES = ± 1/2°
 REMOVE ALL BURRS AND SHARP CORNERS



NOVA DOME

SHEET
3 OF 6

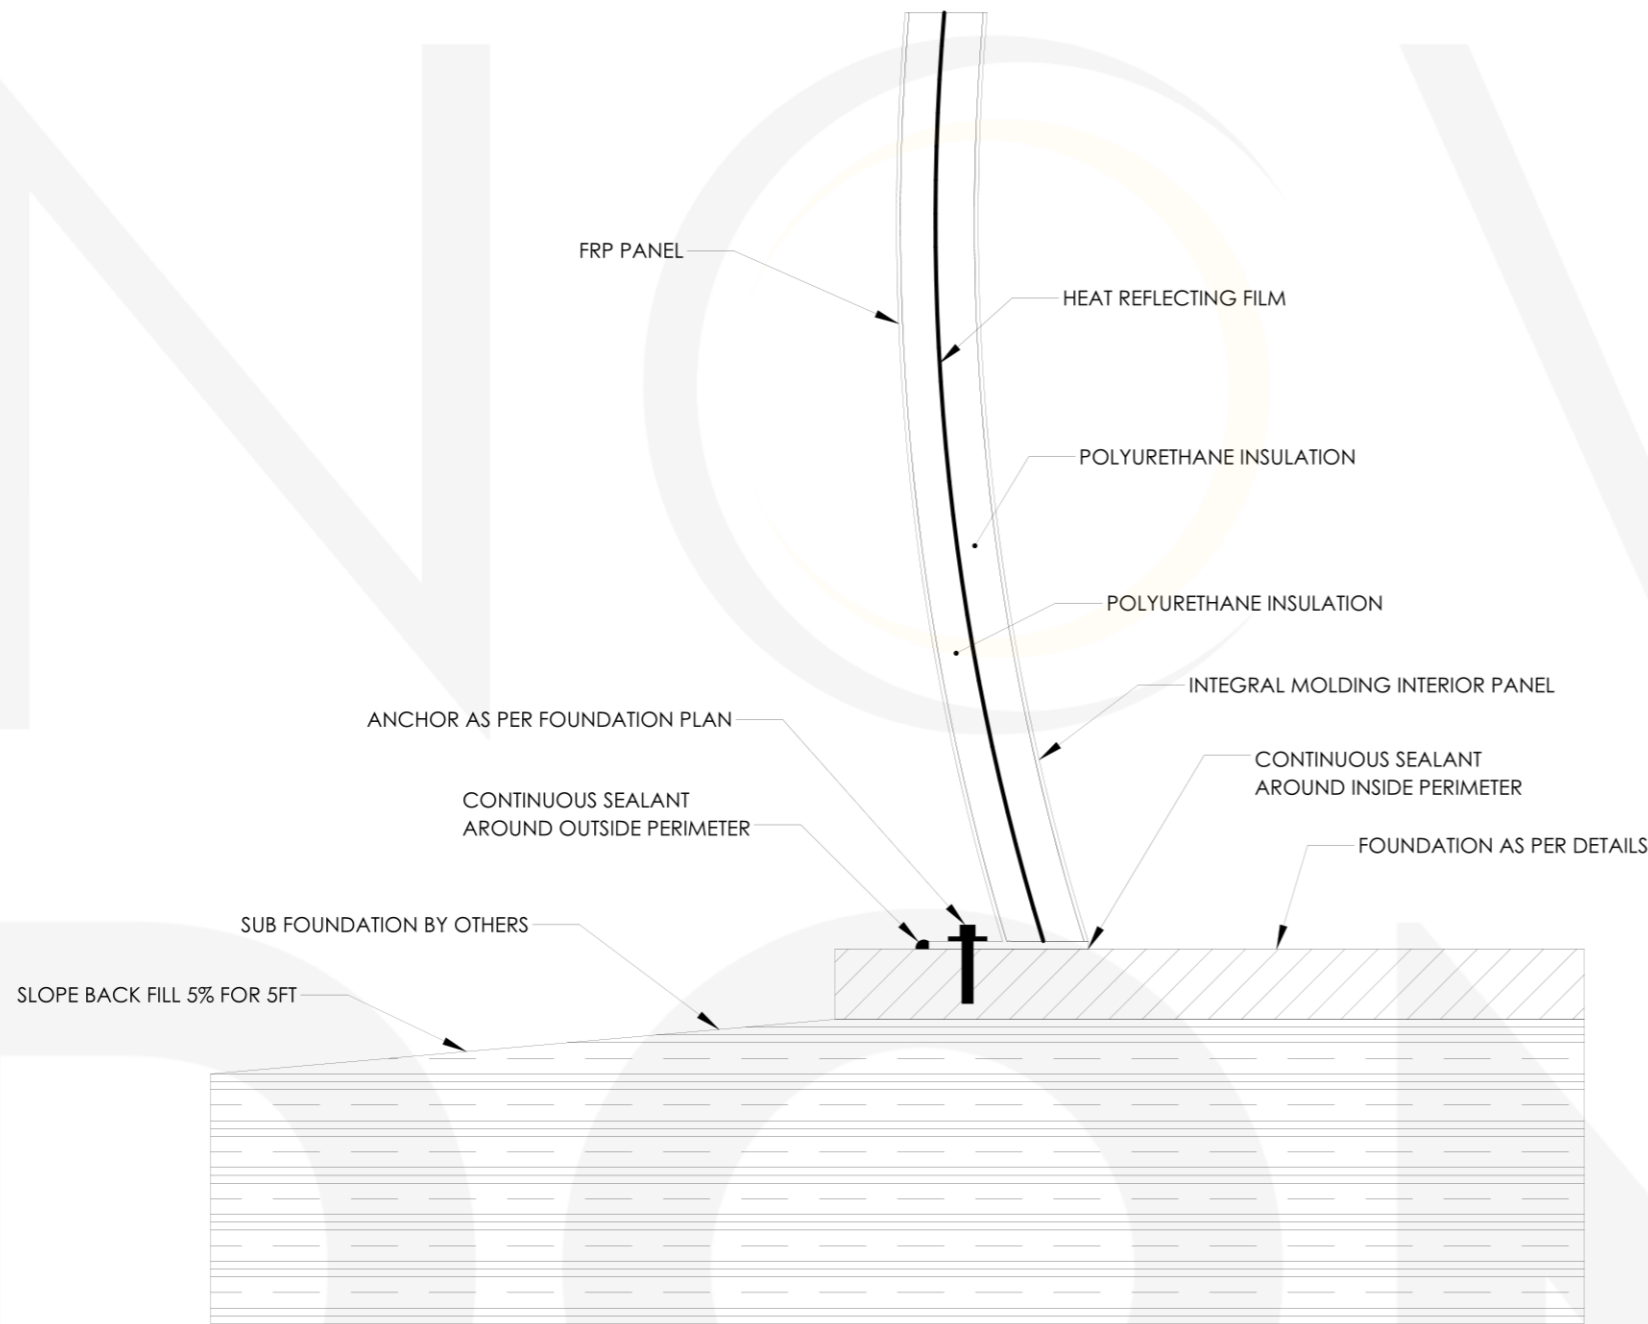

WALL DESCRIPTION:
 - FIBREGLASS DOME
 - POLYURETHANE INSULATION
 - HEAT REFLECTING FILM
 - POLYURETHANE INSULATION
 - INTEGRAL MOLDING INTERIOR PANEL

REV.	DESCRIPTION	LN	DRAWN BY	APPROVED
UNLESS OTHERWISE SPECIFIED FRACTIONS = ± 1/16 .X = ± 0.030 .XX = ± 0.015 .XXX = ± 0.005 ANGLES = ± 1/2° REMOVE ALL BURRS AND SHARP CORNERS				
NOVA DOME				SHEET
				4 OF 6

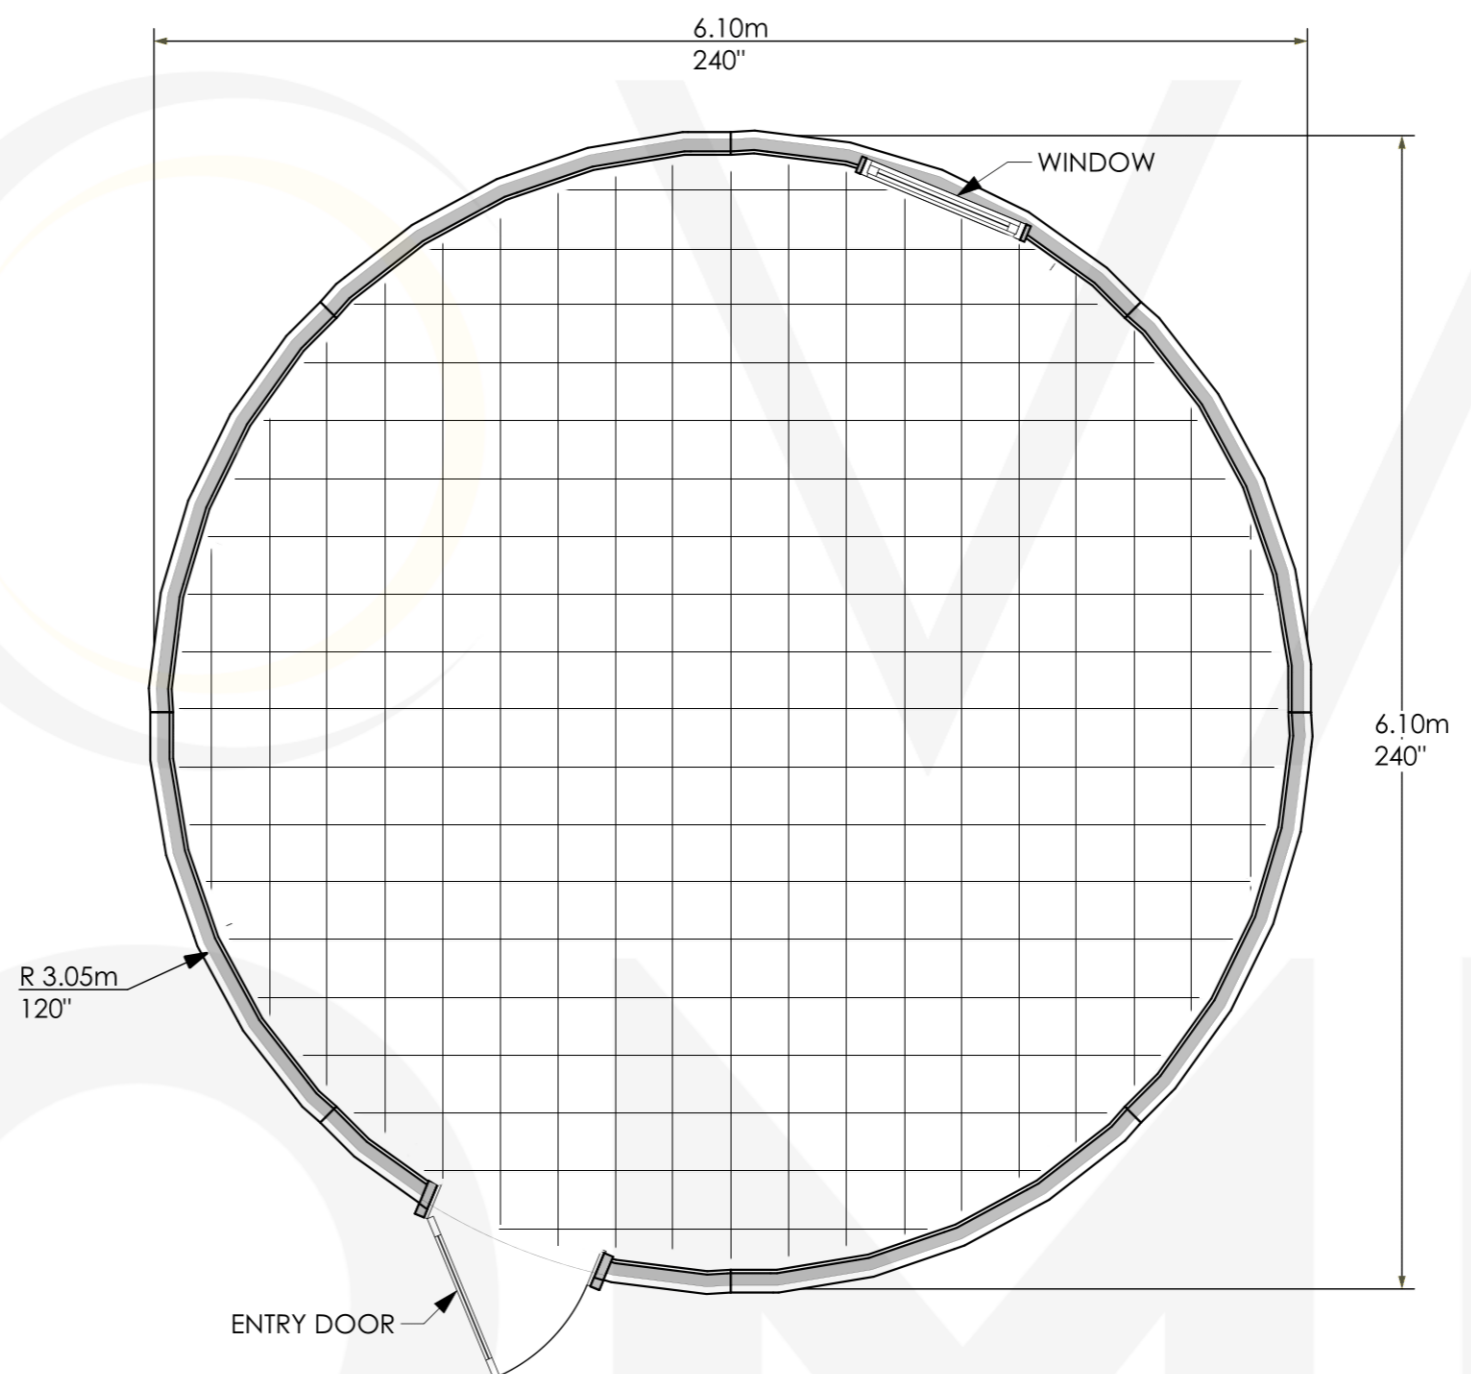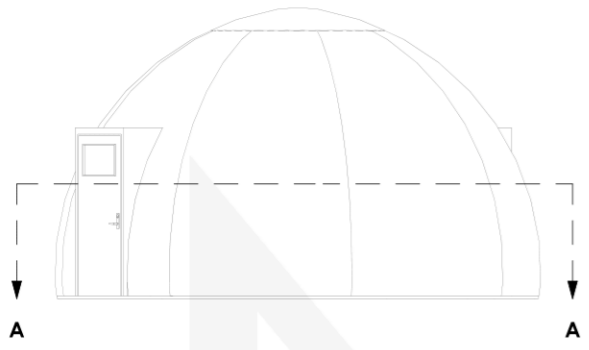

SECTION A-A
SCALE 1:40

REV.	DESCRIPTION	LN	DRAWN BY	APPROVED
UNLESS OTHERWISE SPECIFIED FRACTIONS = ± 1/16 .X = ± 0.030 .XX = ± 0.015 .XXX = ± 0.005 ANGLES = ± 1/2° REMOVE ALL BURRS AND SHARP CORNERS				
				SHEET
				5 OF 6

astro series floor planning layout